
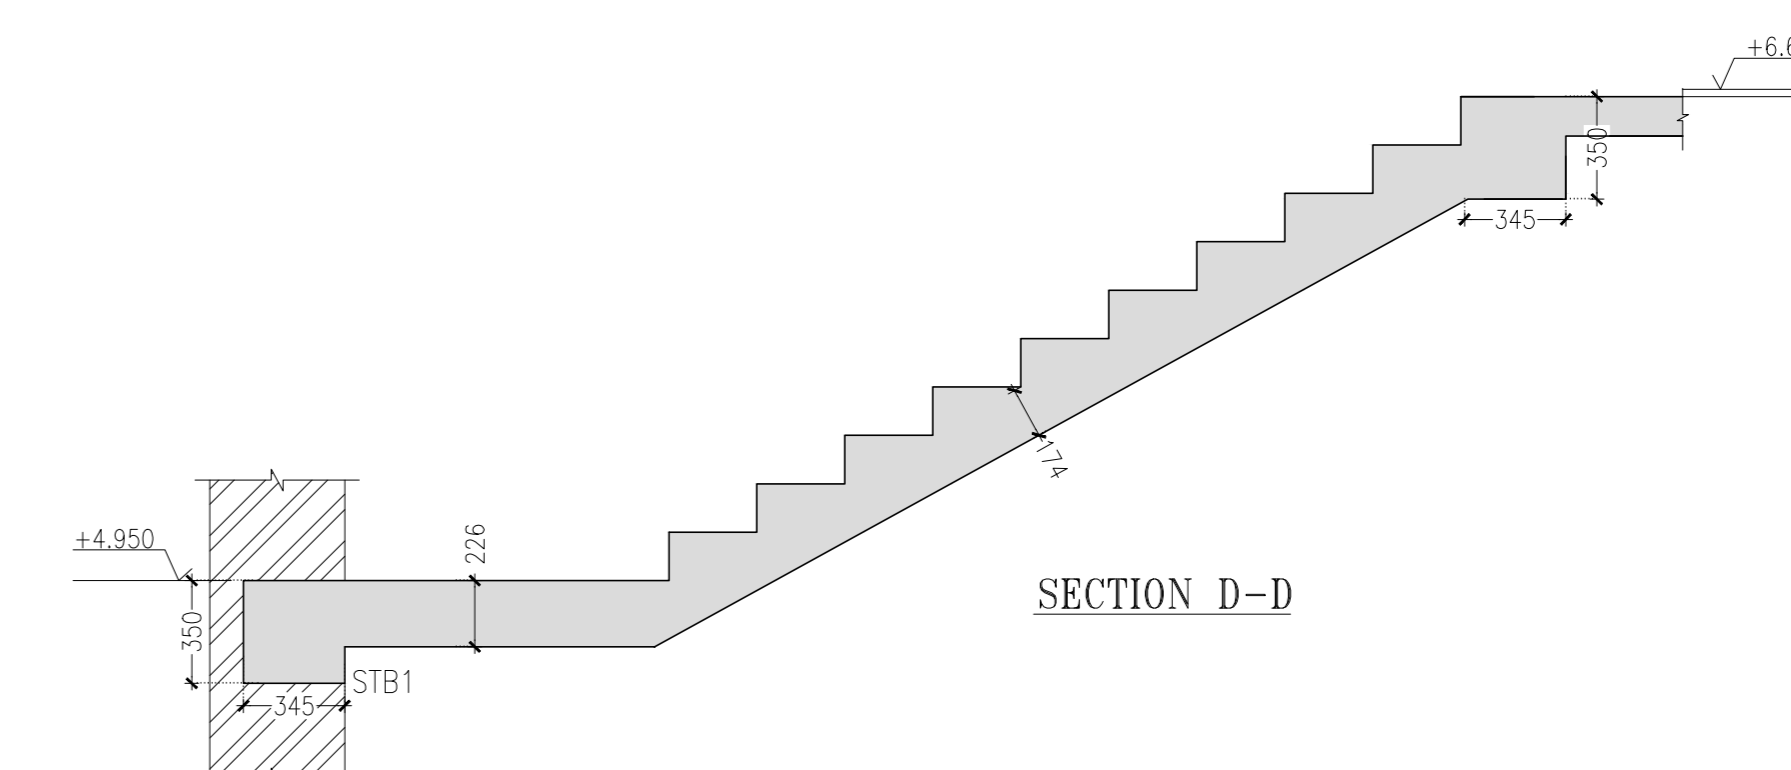


SECOND FLOOR PLAN AT +6.600M LVL.(FIN. FLOOR LVL.)

BEAM SCHEDULE		COLUMN SCHEDULE	
BEAM	SIZE	COLUMN	SIZE
B1	230X350	C1	230X345
B2	345X350	C2	230X230
B3	460X350	C3	345X345

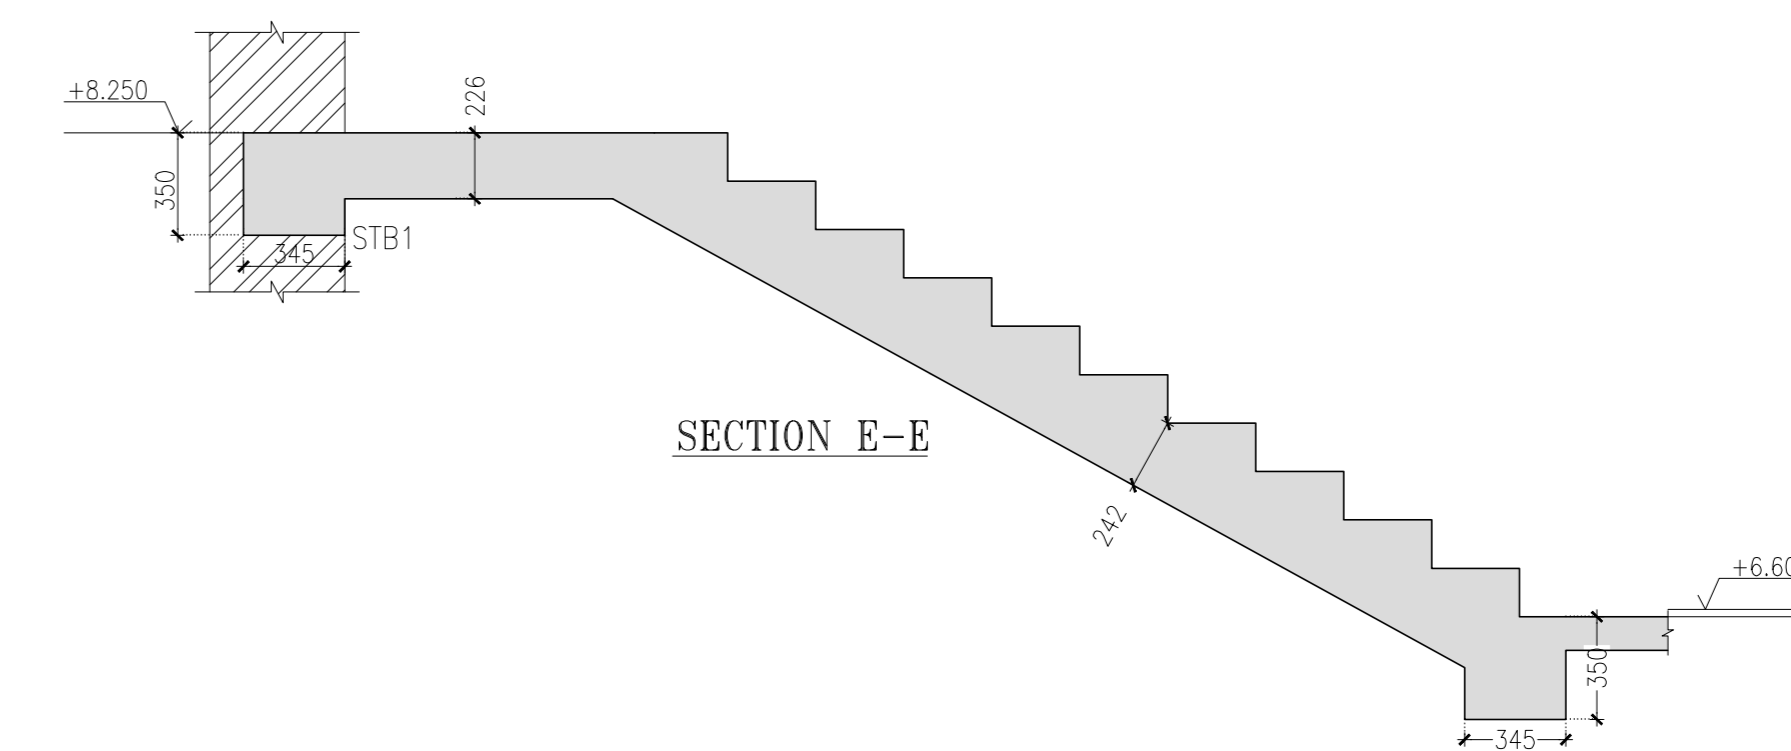

THIS DRAWING IS THE PROPERTY OF VINOD SHAH Consulting Engineers Pvt. Ltd. AND NOT TO BE COPIED OR USED WITHOUT THEIR PERMISSION.

NOTES:

REFERENCE: ALL DIMENSIONS TO BE CHECKED AND CORRELATED WITH ALL RELATED DRAWINGS AND ANY AMBIGUITY SHALL BE IMMEDIATELY BROUGHT TO THE NOTICE OF THE ENGINEER BEFORE COMMENCEMENT OF THE WORK.

DIMENSION: ALL DIMENSIONS ARE MM AND LEVELS ARE IN METER. ALL DIMENSIONS ARE TO BE READ AND NOT TO BE MEASURED.

MASONRY SPEC: ALL MASONRY WALLS SHALL BE CONSTRUCTED FROM BURNT CLAY BRICKS UP TO 300mm LEVEL WITH MIN. COMPRESSIVE STRENGTH OF 7.5 N/mm<sup>2</sup> ON GROSS AREA UNLESS OTHERWISE SPECIFIED. BRICK MASONRY SHALL BE BEDDED WITH CEMENT : SAND MORTAR IN PROPORTION OF 1:4 UNLESS OTHERWISE SPECIFIED.

CEILING SPEC: ALL CEILING MASONRY WALLS SHALL BE CONSTRUCTED FROM COMPRESSED STABILIZED EARTH BLOCK WITH MIN. COMPRESSIVE STRENGTH OF 7.5 N/mm<sup>2</sup> ON GROSS AREA UNLESS OTHERWISE SPECIFIED.

CEILING MASONRY SHALL BE BEDDED WITH CEMENT : SAND MORTAR IN PROPORTION OF 1:4 UNLESS OTHERWISE SPECIFIED.

PRISM TEST IS RECOMMENDED TO ENSURE THE EFFICIENCY OF MASONRY WALL AGAINST COMPRESSED STABILIZED EARTH BLOCK.

CONC. SPEC: ALL CONCRETE MIX USES UNLESS OTHERWISE SPECIFIED.

REINFORCEMENT: R INDICATES TMT STEEL (Fe 500) OF YIELD STRENGTH 500 N/mm<sup>2</sup>.

COVER: CLEAR COVER TO MAIN STEEL IS AS FOLLOWS:  
 RAILES : 50 mm  
 PILE CAP : 40 mm  
 GRADE BEAM : 30 mm  
 FOOTINGS : 50 mm  
 DECK & TOP BOTTOM : 50 mm  
 COLUMNS & PEDESTALS : 40 mm  
 BEAMS & LINTELS : 30 mm  
 SLABS : 25 mm

LEGENDS:  
 COLUMN/WALL STARTS FROM THIS LEVEL.  
 COLUMN/WALL STOPS AT THIS LEVEL.

FOR TENDER PURPOSE ONLY

No.	Date	Remarks
-----	------	---------

Revisions

Date	Prints Issued to	Date	Prints Issued to
------	------------------	------	------------------

Distribution of Prints

Consultants

- **Structural Consultants**  
VINOD SHAH Consulting Engineers Pvt. Ltd.
- **Services Consultants**  
DBHMS
- **Landscape Consultants**  
Earthscapes Consultancy Pvt Ltd
- **Road and Pathways Consultants**  
Ahhmm Infra Consultants LLP

Project  
**Nalanda University, Rajgir, Bihar**

Title  
**STRUCTURAL G.A. DRAWINGS OF SECOND FLOOR PLAN & DETAILS FOR STUDENT HOUSING (TYPE-08)**

Dealt : HS  
 Checked : AJ  
 Date : 09/06/2016

Drawing No.  
 NUC-MSH - S - A.8.7

Scale : 1:50, 1:25

**VASTU SHILPA CONSULTANTS**  
 Architects | Planners | Urban Designers

Sangam, Thaha Road, Arrah, Bihar - 800564  
 Phone: 079-27454537 Fax: 079-27452006  
 www.sangam.org e-mail: vsc@sangam.org