



**DW1 ELEVATION 6 (505 X 310)**  
A 8.4 SCALE - 1:20

**DW1 SECTION 1 (505 X 310)**  
A 8.4 SCALE - 1:20

**DW1 SECTION 2 (505 X 310)**  
A 8.4 SCALE - 1:20

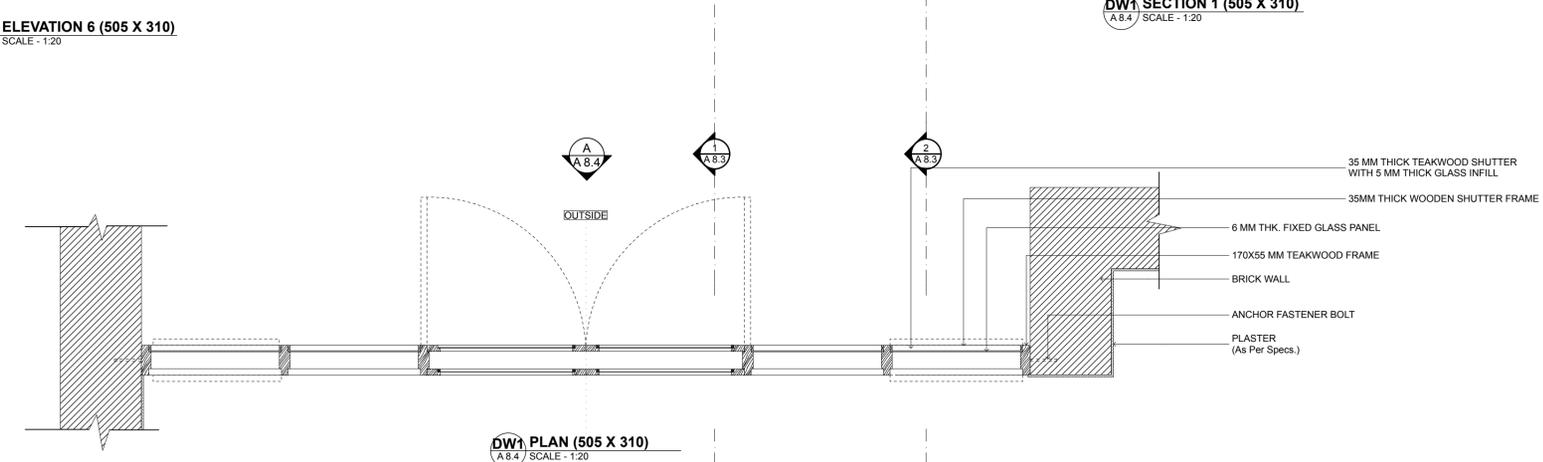

**DW1 PLAN (505 X 310)**  
A 8.4 SCALE - 1:20

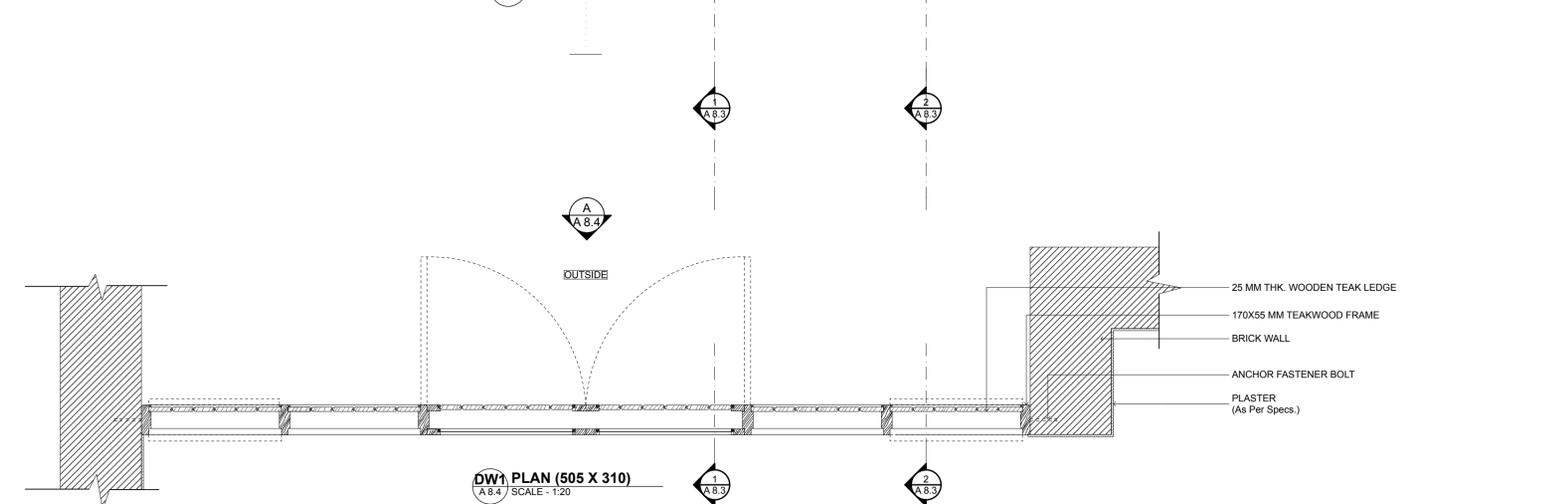


**DW1 PLAN (505 X 310)**  
A 8.4 SCALE - 1:20

**NOTES**  
1. ALL DIMENSIONS SHALL BE CHECKED AND CO-RELATED WITH THE STRUCTURAL DRAWINGS AND ANY AMBIGUITY SHALL BE IMMEDIATELY BROUGHT TO THE NOTICE OF THE ARCHITECT BEFORE COMMENCEMENT OF THE WORK.  
2. ALL DIMENSIONS ARE IN CENTIMETERS UNLESS AND OTHERWISE SPECIFIED.  
3. ALL LEVELS ARE FINISHED LEVELS. ALL DIMENSIONS ARE UNFINISHED MASONRY DIMENSIONS UNLESS AND OTHERWISE SPECIFIED.  
4. ALL MARGINS, CLEARANCES ETC. REQUIRED AS PER BYE-LAWS SHOULD BE CHECKED AND PROVIDED BY THE CONTRACTOR AND ANY DISCREPANCIES FOUND SHOULD BE IMMEDIATELY BROUGHT TO THE NOTICE OF ARCHITECT BEFORE COMMENCEMENT OF WORK.

DOOR SCHEDULE					
NO.	WIDTH (cm)	HEIGHT (cm)	SILL LINTEL (cm)	TYPE	
D1	100	225	-	225	SINGLE SHUTTER FRAME DOOR WITH SCREEN
D2	90	225	-	225	SINGLE SHUTTER FLUSH DOOR
D3	90	210	-	210	SINGLE SHUTTER FLUSH DOOR
D4	75	210	-	210	SINGLE SHUTTER FLUSH DOOR
D5	90	150	-	-	WICKET GATE
DW1	505	310	-	-	B FOLD DOOR WINDOW
DW2	365	310	-	-	SINGLE FOLD DOOR WINDOW
DW3	350	225	-	225	SINGLE FOLD DOOR WINDOW

WINDOW SCHEDULE					
NO.	WIDTH (cm)	HEIGHT (cm)	SILL LINTEL (cm)	TYPE	
W1	140	142.5	82.5	225	2 SHUTTER WOODEN WINDOW
W2	90	142.5	82.5	225	2 SHUTTER WOODEN WINDOW
W3	75	88.5	138.5	225	1 SHUTTER WOODEN WINDOW
W4	60	71.5	133.5	225	1 SHUTTER WOODEN WINDOW
W5	60	142.5	82.5	225	TOILET WINDOW TYPE 1
W6	60	109.5	115.5	225	TOILET WINDOW TYPE 2
W7	60	78.5	148.5	225	TOILET WINDOW TYPE 3
W8	45	210	15	225	1 SHUTTER WOODEN WINDOW
W9	75	78.5	148.5	225	2 SHUTTER WOODEN WINDOW
W10	100	127.5	-	-	2 SHUTTER WOODEN WINDOW
W11	150	142.5	82.5	225	3 SHUTTER WOODEN WINDOW
W12	60	65	160	225	1 SHUTTER WOODEN WINDOW
W13	225	78.5	82.5	150	3 SHUTTER WOODEN WINDOW
W14	75	109.5	115.5	225	2 SHUTTER WOODEN WINDOW
W15	75	109.5	115.5	225	LOUVRES WITH FLYMESH
W16	90	110.5	71.5	182	1 SHUTTER WOODEN WINDOW
W17	90	165.5	16.5	182	FIXED GLASS WINDOW
W18	350	190	260	450	FIXED GLASS WINDOW
W19	350	175.5	260	435.5	FIXED GLASS WINDOW
W20	350	190	260	450	FIXED GLASS WINDOW
W21	45	190	260	450	FIXED GLASS WINDOW

**TENDER DRAWING**

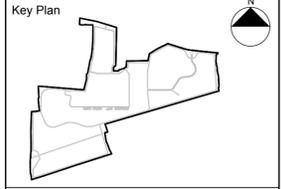

- Consultants**
- Structural Consultants**  
VR SHAH Consulting Engineers
  - Services Consultants**  
DBHMS
  - Landscape Consultants**  
Earthscape Consultancy Pvt Ltd
  - Road and Pathways Consultants**  
Arhmm Infra Consultants LLP

**Project**  
**Nalanda University, Rajgir, Bihar**

**Title**  
**Faculty Bungalow**  
**Door Details**

Dealt : Anshul Goel  
Checked : Janardhan  
Scale : 1:20  
Date : 10/7/16

Drawing No.  
NUC(1)-FRH-A-8.2